

Ordnance Survey (c) Crown Copyright 2019. All rights reserved. Licence number 100022432



- C This drawing is copyright of Condy and Lofthouse Ltd. and may not be reproduced in any way without their specific permission.
- All dimensions are to be checked on site. Do not scale from this drawing, work to figured dimensions only. Any queries please contact the architects.

# ○ MATERIALS PROHIBITED

Materials prohibited from use, except where used in accordance with 'Good Practice in the Selection of Construction Materials (March 2011)' or unless required by the Contract:

- a) high alumina cement in the structural elements;
- wood wool slabs in permanent formwork to concrete;
- c) calcium chloride admixtures for use in reinforced concrete;
- asbestos or asbestos-containing products, as defined in the 'Control of Asbestos at Work Regulations, as amended 2012' or any other statutory modification or reenactment thereof:
- any naturally occurring or man made mineral fibres (for example, rock-wool or slag wool) with a thickness of 3 microns or less and a length of 200 microns or less, unless they are appropriately sealed to prevent migration of fibres;
- aggregates for use in reinforced concrete which do not comply with: '85 EN 12620:2002: properties of aggregates used in concrete.
  - 'BS EN 13139:2002: Properties of aggregates used in mortar.
  - 'BS EN 13055 (Parts 1 & 2): properties of lightweight aggregates.
  - 'Guidance on avoiding alkali-silica reaction and limitations on alkali content in BRE Digest 330 (2004)' & 'Concrete Society Technical Report 30 (1999)';
- g) lead, lead paint or any other materials containing lead which may be ingested, inhaled or absorbed, except where copper alloy fittings also containing lead are

specifically required in drinking water pipework by any relevant statutory requirement or where lead flashings or other lead roof coverings are specifically provided for in the Contract:


- b) urea formaldehyde foam or materials which may release formaldehyde in quantities which may be hazardous with reference to the limits set by the Health and Safety Executive;
- calcium silicate bricks or tiles;
- vermiculite unless it is established as being fibre-free; calcium silicate bricks or tiles;
- any products containing cadmium referred to in Statutory Instrument SI 2006/3311 Controls on dangerous substances and preparations Regulations 2006'. Reference should also be made to 'HSE IDGE391 Cadmium and you':
- ) any new timber treated with pentachlorophenol;
- non galvanised mild steel structural fixings for building elements particularly susceptible to erosion;
- concrete used in circumstances where it is susceptible to alkali/silica reaction;
- o) materials containing chlorofluorocarbons (CFC's);
- solvent based paints except where water based paints are unsultable for unavailable;
  any new materials not in accordance with statutory requirements, British Standards,
  Codes of Practice and good building practice current at the date of incorporation of the relevant materials into the Works or the specifications thereof;

0
(B) House shape amended. Feb 2020 / SAJ
(A) Site boundary line amended. Dec 2019 / SAJ
★ First Issue Sept 2019 / pjw
REVISION DETAILS date / bv
O Preliminary
For Approval
$\bigcirc$ Tender
$\bigcirc$ Construction
CLIENI
Young Foundations
PROJECT
Oaklea Grange, Sandy Lane, Hope,
Wrexham, LL12 9RP
DRAWING TITLE
Site Location Plan
SCALE drawn by date
1:1250@A3 pjw Sept 2019
DRAWING NO. revision
DRAWING NO. revision 19-140-100 (B)
19-140-100 B



T: 0151 207 4371 • F: 0151 207 7087

Abbreviations/Sy	mbols (Measured Building Surveys):				
C:	Window Cill Height				
H: BH:	Window Head Height				
DH:	Beam Height Door Height				
COL: SVP:	Column Soil Vent Pipe				
FL:	Floor Level				
TH:	Threshold Level				
2.50	Floor to Ceiling Height				
	Vaulted Ceiling				
Line types					
$\sim$					
	Hedge Lines				
	Drainage Runs Overhead Electricity Cables				
V T	Overhead Telephone Cables				
<u>Symbols</u>					
$\frown$					
(•)	Tree/Bush	Glass House			
- A -	Control Station	Osbm			
		03011			
$ $ $\oplus$	Borehole				
	Trial Hole				
Abbreviations (To	pographic Survey):				
AH:	Arch Height				
AV:	Air Valve				
BB: BOX:	Belisha Beacon Electricity Box, Cables Box, Etc.				
BOL:	Bollard				
BT/IC: BS:	British Telecom Inspection Chamber Bus Stop				
BS/LP:	Bus Stop / Lamp Post				
CATV: CCTV:	CATV Inspection Chamber Closed Circuit Television				
CL: C.PIT:	Cellar Light Catch Pit				
ER:	Earth Rod				
EC: EP:	Electricity Inspection Chamber Electricity Pole				
FH:	Fire Hydrant				
FP: GV:	Flag Pole Gas Valve				
G:	Gully				
IC: KO:	Inspection Chamber Kerb Outlet				
LP:	Lamp Post				
LB: LC:	Letter Box Lighting Column				
MKR:	Marker				
MH: MP:	Manhole Mooring Point				
MS:	Mile Stone				
NYNEX: O/H:	Nynex Inspection Chamber Over Hang				
P:	Post Bost Office Inspection Chamber				
PO/IC: R/S:	Post Office Inspection Chamber Road Sign				
RE: RTW:	Rodding Eye Retaining Wall				
S/P:	Sign Post				
SNP: ST:	Street Name Plate Stop Tap				
SV:	Stop Valve				
T: TCB:	Telecom Inspection Chamber Telephone Call Box				
TH:	Threshold Level				
TL: TP:	Traffic Light Telegraph Pole				
TROUGH: WO:	Trough Water Outlet				
WO: WM:	Water Meter				
Fence Description	<u>15:</u>				
B/W:	Barbed Wire				
C/B: C/BARRIER:	Close Boarded Crash Barrier				
C/L:	Chain Link				
C/P: C/I:	Chestnut Paling Corrugated Iron				
I/R:	Iron Railing				
MISC: P/R:	Miscellaneous Post & Rail				
P/W:	Post & Wire				
P/C: S/PAL:	Post & Chain Steel Palisade				
W/M:	Wire Mesh				

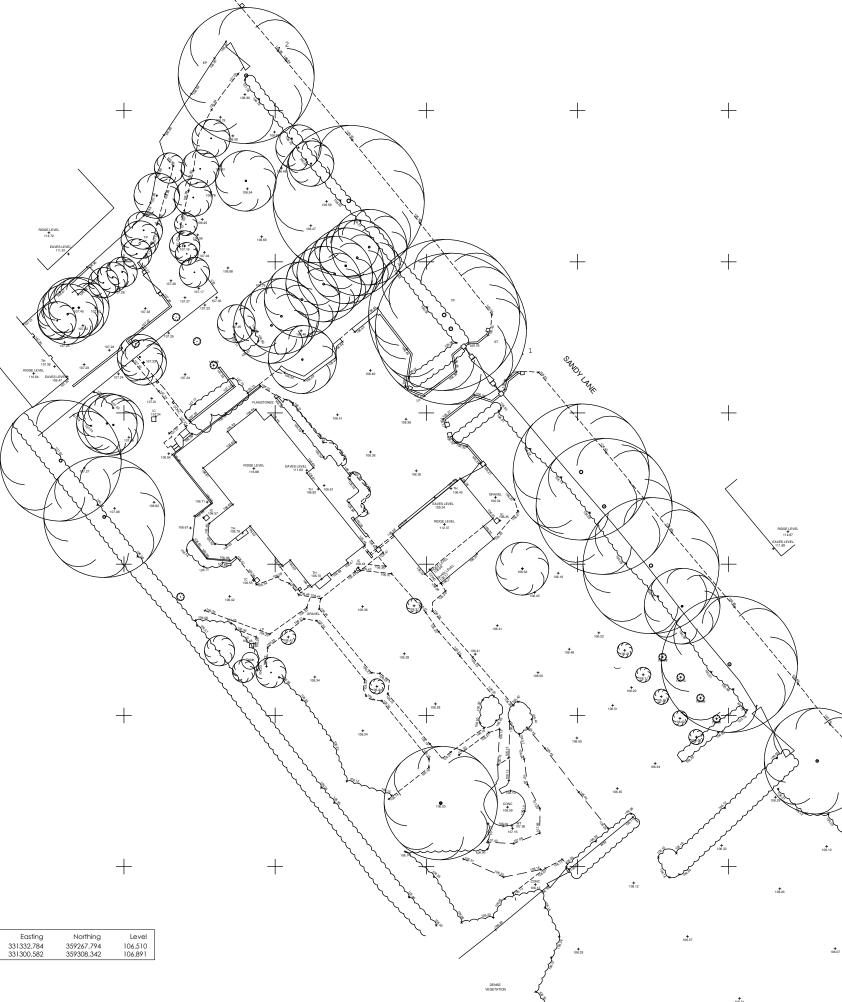

011019CP-01 dated October 2019

Drawing based on Chris Partington Land Surveyors (CPLS) drawing

Station

Existing Site Plan 1:500 @ A3

Note:



+

+


105 70

### $\bigcirc$ NOTES

- C This drawing is copyright of Condy and Lofthouse Ltd. and may not be reproduced in any way without their specific permission.
- All dimensions are to be checked on site. Do not scale from this drawing, work t figured dimensions only. Any queries please contact the architects.

### $\bigcirc$ MATERIALS PROHIBITED

- high alumina cement in the structural elements;
- wood wool slabs in permanent formwork to concrete;
- calcium chloride admixtures for use in reinforced concrete;
- asbestos or asbestos-containing products, as defined in the 'Control of Asbestos at Work Regulations, as amended 2012' or any other statutory modification or re-
- any naturally occurring or man made mineral fibres (for example, rock-wool or slag wool) with a thickness of 3 microns or less and a length of 200 microns or less, unless they are appropriately sealed to prevent migration of fibres;
- aggregates for use in reinforced concrete which do not comply with:
  - 'BS EN 12620:2002: properties of aggregates used in concrete 'BS EN 13139:2002: Properties of aggregates used in mortar.
  - BS EN 13139:2002: Properties of aggregates used in mortar.
    BS EN 13055 (Parts 1 & 2): properties of lightweight aggregates
  - bs en 13035 (Paris 1 & 2), properties of lightweight aggregate:
  - 'Guidance on avoiding alkali-silica reaction and limitations on alkali content in BRE Digest 330 (2004)' & 'Concrete Society Technical Report 30 (1999)';
- g) lead, lead paint or any other materials containing lead which may be ingested, inholed or absorbed, except where copper alloy fittings also containing lead are specifically required in dirinking water pipework by any relevant statutory requirement or where lead flashings or other lead roof coverings are specifically provided for in the Contract;
- h) urea formaldehyde foam or materials which may release formaldehyde in quantities which may be hazardous with reference to the limits set by the Health and Safety Eventifier.
- calcium silicate bricks or tiles;
- yermiculite unless it is established as being fibre-free; calcium silicate bricks or files;
- any products containing cadmium referred to in Statutory Instrument S1 2006/3311 Controls on dangerous substances and preparations Regulations 2006. Reference should also be made to 'HSE IDGE391 Cadmium and you';
- any new timber treated with pentachlorophenol;
- non galvanised mild steel structural fixings for building elements particularly susceptible to erosion;
- concrete used in circumstances where it is susceptible to alkali/silica reaction;
- materials containing chlorofluorocarbons (CFC's);
- ) solvent based paints except where water based paints are
- ) any new materials not in accordance with statutory requirements, Brilish Standards, Codes of Practice and good building practice current at the date of incorporation of
- the relevant materials into the Works or the specifications thereof;

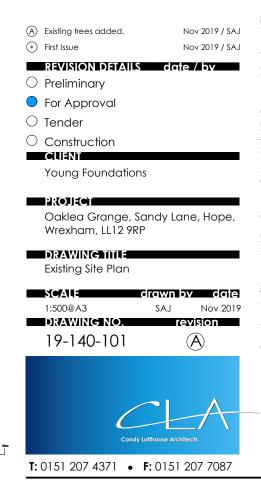



Drawing based on Chris Partington Land Surveyors (CPLS) drawing 081019HH-01 dated October 2019

> Home - Proposed Elevation 1 of 4 1:100 @ A3



Key

Existing retained



(4)

3

(2)


### $\bigcirc$ NOTES

- C This drawing is copyright of Condy and any way without their specific permission
- All dimensions are to be checked on site. Do not scale from this drawing, work to figured dimensions only. Any queries please contact the architects.

### O MATERIALS PROHIBITED


Atterials prohibited from use, except where used in accordance with 'Good Practice in Aaterials (March 2011)' or unless

- calcium chloride admixtures for use in reinforced co
- asbestos or asbestos-containing products, as defined in the 'Control of Asbestos a Work Regulations, as am ended 2012' or any other statutory modification or re
- any naturally occurring or man made mineral fibres (for example, rock-wool or slag rool) with a thickness of 3 microns or less and a length of 200 microns or less, unless migration of fibres they are appropriately sealed to preven
- aggregates for use in reinforced concrete which do not comply with 'BS EN 12620:2002: properties of aggregates used in concrete. 'BS EN 13139:2002: Properties of aggregates used in mortar.
  - 'BS EN 13055 (Parts 1 & 2): properties of lightweight aggregates
  - Guidance on avoiding alkali-silica reaction and limitations on alkali cor BRE Digest 330 (2004)' & 'Concrete Society Technical Report 30 (1999)';
- lead, lead paint or any other materials containing lead which may be ingested nhaled or absorbed, except where copper alloy fittings also specifically required in drinking water pipework by any relevant statutory requireme where lead flashings or other lead roof co erings are specifically p Contract;
- urea forn which may be h ardous with reference to the limits set by the Health and Executive;
- calcium silicate
- vermiculite unless it is established as being fibre-free
- any products containing cadmium referred to in Statutory Instrument 'SI Controls on dangerous substances and preshould also be made to 'HSE IDGE391 Cadmium and v
- any new timber treated with pentachlorophene
- non galvanised mild steel structural fixings for bu to erosion-
- concrete use
- materials containing chlorofluorocarbons (CFC's):
- solvent based paints except where water based
- any new materials not in accordance with statutory requirements. British Standards Codes of Practice and good building practice current at the date of inco the relevant materials into the Works or the specifications thereof;
- (B) Updated in accordance with meeting comments 06-02-2020. Feb 2020 / SAJ (A) Key plan & north point added. Design development. Nov 2019 / SAJ ★ First Issue Nov 2019 / SAJ REVISION DETAILS date / bv ○ Preliminary For Approval  $\bigcirc$  Construction CLIENT Young Foundations

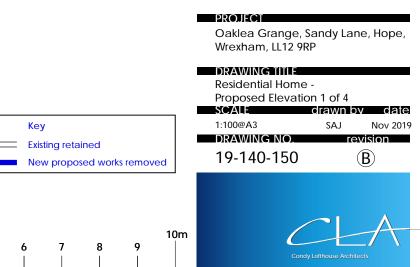

T: 0151 207 4371 • F: 0151 207 7087




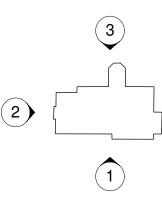



Drawing based on Chris Partington Land Surveyors (CPLS) drawing 081019HH-01 dated October 2019

> Home - Proposed Elevation 2 of 4 1:100 @ A3

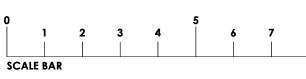

Key

Existing retained




### $\bigcirc$ NOTES

- C This drawing is copyright of Condy and any way without their specific permission
- All dimensions are to be checked on site. Do not scale from this drawing figured dimensions only. Any queries please contact the architects.

### O MATERIALS PROHIBITED

- wood wool slabs in permanent formwork to concrete
- calcium chloride admixtures for use in reinforced cor
- asbestos or asbestos-containing products, as defined in the 'Control of Asbestos at Work Regulations, as amended 2012' or any other statutory modification or reenactment thereof;
- any naturally occurring or man made mineral fibres (for example, rock-wool or slag wool) with a thickness of 3 microns or less and a length of 200 microns or less, unless hey are appropriately sealed to prevent migration of fibres;
- aggregates for use in reinforced concrete which do not comply with:
  - 'BS EN 12620:2002: properties of aggregates used in concrete.
  - 'BS EN 13139:2002: Properties of aggregates used in mortar.
  - 'BS EN 13055 (Parts 1 & 2): properties of lightweight aggregates.
  - 'Guidance on avoiding alkali-silica reaction and limitations on alkali content BRE Digest 330 (2004)' & 'Concrete Society Technical Report 30 (1999)';
- lead, lead paint or any other materials containing lead which may be ingested, inhaled or absorbed, except where copper alloy fittings also containing lead are specifically required in drinking water pipework by any relevant statutory requirement or where lead flashings or other lead roof coverings are specifically provided for in the Contract;
- urea form which may be hazardous with reference to the limits set by the Health and Safety Executive;
- calcium silicate bricks or tile
- vermiculite unless it is established as being fibre-free; calcium silicate bricks or tiles
- any products containing cadmium referred to in Statutory Instrument 'SI 2004/3311 Controls on dangerous substances and preparations Regulations 2006' Reference should also be made to 'HSE IDGE391 Cadmium and you'
- any new timber treated with pentachlorophenol;
- non galvanised mild steel structural fixings for building ele to erosion:
- concrete used in circu
- materials containing chlorofluorocarbons (CFC's):
- solvent based paints except where water based paints a
- any new materials not in accordance with statutory requirements. British Standards Codes of Practice and good building practice current at the date of incorporation of
- the relevant materials into the Works or the specifications thereof;

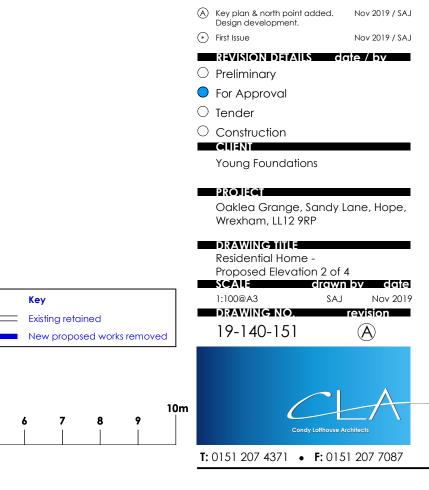





Drawing based on Chris Partington Land Surveyors (CPLS) drawing 081019HH-01 dated October 2019

> Home - Proposed Elevation 3 of 4 1:100 @ A3



Key

Existing retained



3


(2)

# $\bigcirc$ NOTES


- C This drawing is copyright of Condy an any way without their specific permission
- All dimensions are to be checked on site. Do not scale from this drawing figured dimensions only. Any queries please contact the architects.

# ○ MATERIALS PROHIBITED

- wood wool slabs in permanent formwork to concrete
- calcium chloride admixtures for use in reinforced co
- asbestos or asbestos-containing products, as defined in the 'Control of Asbestos at Work Regulations, as amended 2012' or any other statutory modification or reenactment thereof;
- any naturally occurring or man made mineral fibres (for example, rock-wool or slag wool) with a thickness of 3 microns or less and a length of 200 microns or less, unless hey are appropriately sealed to prevent migration of fibres;
- aggregates for use in reinforced concrete which do not comply with:
  - 'BS EN 12620:2002: properties of aggregates used in concrete.
  - 'BS EN 13139:2002: Properties of aggregates used in mortar.
  - 'BS EN 13055 (Parts 1 & 2): properties of lightweight aggregates.
  - 'Guidance on avoiding alkali-silica reaction and limitations on alkali conten BRE Digest 330 (2004)' & 'Concrete Society Technical Report 30 (1999)';
- lead, lead paint or any other materials containing lead which may be ingested, nhaled or absorbed, except where copper alloy fittings also containing lead are specifically required in drinking water pipework by any relevant statutory requirement or where lead flashings or other lead roof coverings are specifically pro-Contract;
- urea form which may be hazardous with reference to the limits set by the Health and Safety Executive;
- calcium silicate bricks or tile
- vermiculite unless it is established as being fibre-free; calcium silicate bricks or tiles
- any products containing cadmium referred to in Statutory Instrument 'SI 2006/3311 Controls on dangerous substances and preparations Regulations 2006' Reference should also be made to 'HSE IDGE391 Cadmium and you
- any new timber treated with pentachlorophenol;
- non galvanised mild steel structural fixings for building to erosion:
- concrete used in cire
- materials containing chlorofluorocarbons (CFC's):
- solvent based paints except where water based paints
- any new materials not in accordance with statutory requirements. British Standards Codes of Practice and good building practice current at the date of incorporation of the relevant materials into the Works or the specifications thereof;

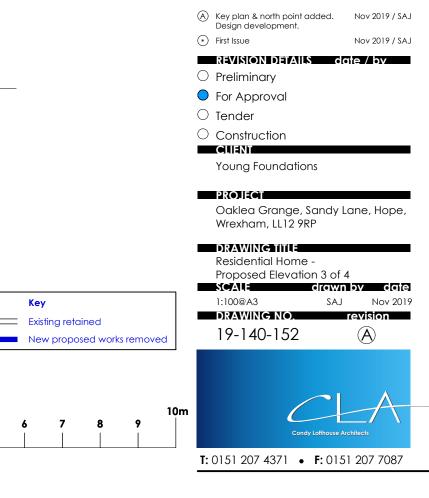




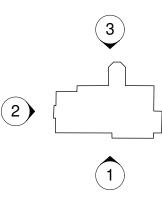



Drawing based on Chris Partington Land Surveyors (CPLS) drawing 081019HH-01 dated October 2019

> Home - Proposed Elevation 4 of 4 1:100 @ A3

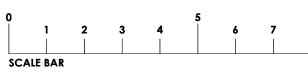

Key

Existing retained




### $\bigcirc$ NOTES


- C This drawing is copyright of Condy and any way without their specific permission
- All dimensions are to be checked on site. Do not scale from this drawing, figured dimensions only. Any queries please contact the architects.

### ○ MATERIALS PROHIBITED

- wood wool slabs in permanent formwork to concrete
- calcium chloride admixtures for use in reinforced cor
- asbestos or asbestos-containing products, as defined in the 'Control of Asbestos at Work Regulations, as amended 2012' or any other statutory modification or reenactment thereof;
- any naturally occurring or man made mineral fibres (for example, rock-wool or slag wool) with a thickness of 3 microns or less and a length of 200 microns or less, unless hey are appropriately sealed to prevent migration of fibres;
- aggregates for use in reinforced concrete which do not comply with:
  - 'BS EN 12620:2002: properties of aggregates used in concrete.
  - 'BS EN 13139:2002: Properties of aggregates used in mortar.
  - 'BS EN 13055 (Parts 1 & 2): properties of lightweight aggregates.
  - 'Guidance on avoiding alkali-silica reaction and limitations on alkali content BRE Digest 330 (2004)' & 'Concrete Society Technical Report 30 (1999)';
- lead, lead paint or any other materials containing lead which may be ingested, inhaled or absorbed, except where copper alloy fittings also containing lead are specifically required in drinking water pipework by any relevant statutory requirement or where lead flashings or other lead roof coverings are specifically provided for in the Contract;
- urea form which may be hazardous with reference to the limits set by the Health and Safety Executive;
- calcium silicate bricks or tile
- vermiculite unless it is established as being fibre-free; calcium silicate bricks or tiles
- any products containing cadmium referred to in Statutory Instrument 'SI 2004/3311 Controls on dangerous substances and preparations Regulations 2006' Reference should also be made to 'HSE IDGE391 Cadmium and you'
- any new timber treated with pentachlorophenol;
- non galvanised mild steel structural fixings for building e to erosion:
- concrete used in circu
- materials containing chlorofluorocarbons (CFC's):
- solvent based paints except where water based paints of
- any new materials not in accordance with statutory requirements. British Standards Codes of Practice and good building practice current at the date of incorporation of
- the relevant materials into the Works or the specifications thereof;

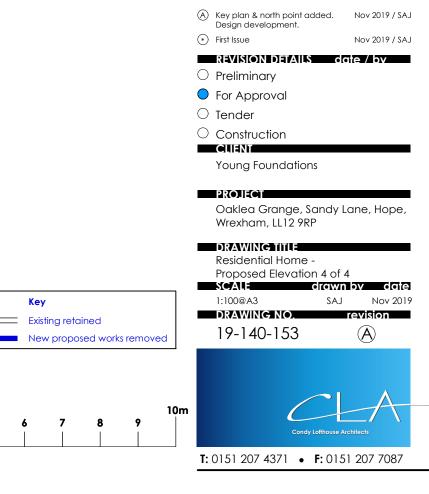



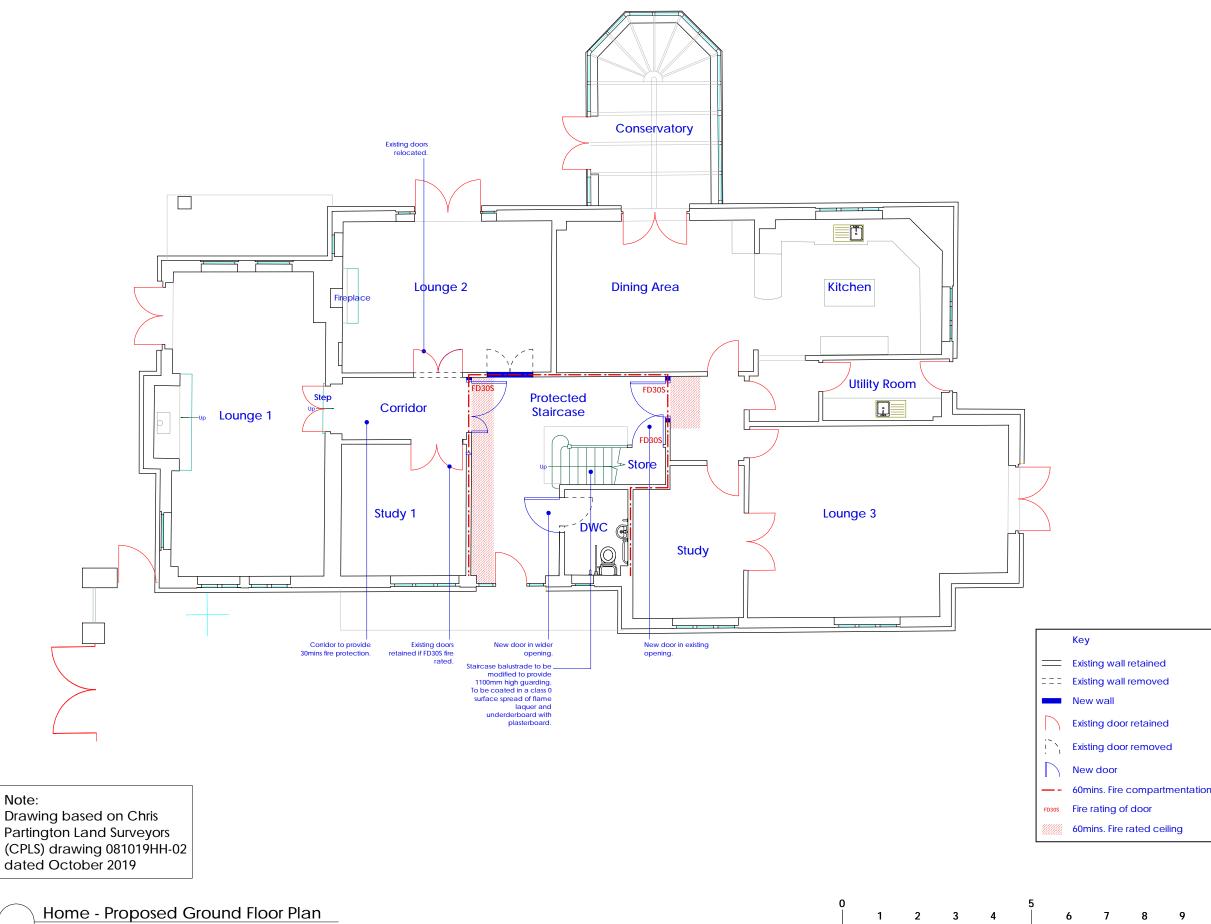

1:100 @ A3



# $\bigcirc$ NOTES

- C This drawing is copyright of Condy and L any way without their specific permission
- All dimensions are to be checked on site. Do not scale from this drawing, work to figured dimensions only. Any queries please contact the architects

### O MATERIALS PROHIBITED

Materials prohibited from use, except where used in accordance with 'Good Practice in instruction Materials (March 2011)' or unless requ

- wood wool slabs in perma nent formwork to concre
- calcium chloride admixtures for use in reinforced co
- asbestos or asbestos-containing products, as defined in the 'Control of Asb Work Regulations, as amended 2012' or any other statutory modification or re-
- any naturally occurring or man made mineral fibres (for example, rock-wool or slag ool) with a thickness of 3 microns or less and a length of 200 microns or less, unless they are appropriately sealed to prevent migration of fibres;
- aggregates for use in reinforced concrete which do not comply with 'BS EN 12620:2002: properties of aggregates used in concrete 'BS EN 13139:2002: Properties of aggregates used in mortar.
  - 'BS EN 13055 (Parts 1 & 2): properties of lightweight aggregates
  - Guidance on avoiding alkali-silica reaction and limitations on alkali co BRE Digest 330 (2004)' & 'Concrete Society Technical Report 30 (1999)';
- ead, lead paint or any other materials containing lead which may be ingeste haled or absorbed, except where copper alloy fittings also quired in drinking water pipework by any relevant sta where lead flashings or other lead roof c Contract
- urea for ardous with reference to the limits set by the Health ar Executive;
- calcium silicate
- vermiculite unless it is established as being fibre-free
- any products containing cadmium referred to in Statutory Inst Controls on dangerous substances and pre should also be made to 'HSE IDGE391 Cadmium and y
- any new timber treated with pentachloror
- non galva to erosion
- concrete u
- materials containing chlorofluorocarbons (CFC's):
- solvent based paints except where water based any new materials not in accordance with statutory requirements. British Standards
- Codes of Practice and good building practice current at the date of incor the relevant materials into the Works or the specifications thereof;

C	Updated in accordance with meeting comments 06-02-2020.	Feb 2020 / SAJ
B	DWC added to front entrance lobby.	Nov 2019 / SAJ
A	North point added.	Nov 2019 / SAJ
(	First Issue	Nov 2019 / SAJ
	REVISION DETAILS da	te / bv

Oaklea Grange, Sandy Lane, Hope,

SAJ

 $\bigcirc$ 

- O Preliminary
- For Approval
- $\bigcirc$  Construction

PROJECT

SCALE

1:100@A3

DRAWING NO.

19-140-120

CLIENT

Young Foundations

Wrexham, LL12 9RP


**Residential Home -**

DRAWING TITLE

SCALE BAR

10m

T: 0151 207 4371	•	F: 0151 207 7087

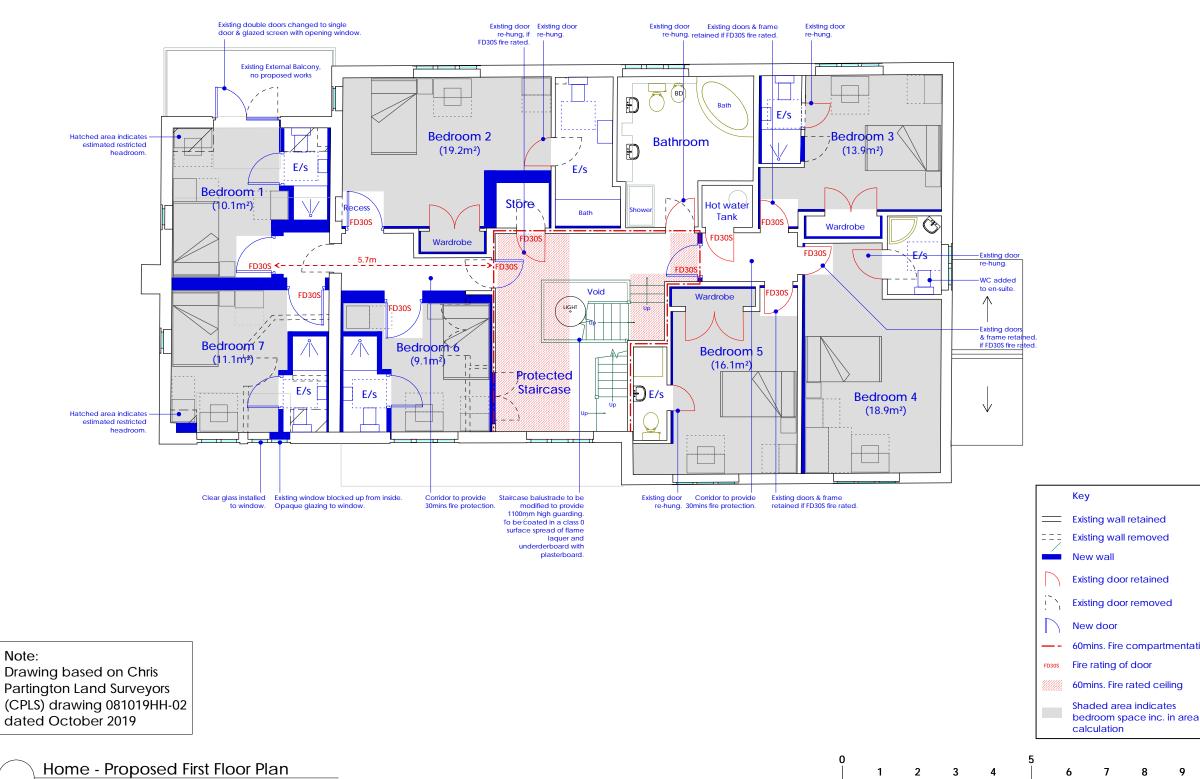

1:100 @ A3



### ○ NOTES

- C This drawing is copyright of Condy and Lo any way without their specific permission
- All dimensions are to be checked on site. Do not scale from this drawing, work to figured dimensions only. Any queries please contact the architects. ions only. Any queries plea

### ○ MATERIALS PROHIBITED


als prohibited from use, except where used in accordance with 'Good Practice in the Selection of Construction Materials (March 2011)' or unless required by

- wood wool slabs in permanent formwork to concret
- calcium chloride admixtures for use in reinforced cond
- asbestos or asbestos-containing products, as defined in the 'Control of Asbestos a Work Regulations, as amended 2012' or any other statutory modification or re enactment thereo
- any naturally occurring or man made mineral fibres (for example, rock-wool or slag ool) with a thickness of 3 microns or less and a length of 200 microns or less, unles they are appropriately sealed to prevent migration of fibres
- aggregates for use in reinforced concrete which do not comply with 'BS EN 12620:2002: properties of aggregates used in concrete
  - 'BS EN 13139:2002: Properties of aggregates used in mortar.
  - 'BS EN 13055 (Parts 1 & 2): properties of lightweight aggregates nce on avoiding alkali-silica reaction and limitations on alkali cor
  - BRE Digest 330 (2004)' & 'Concrete Society Technical Report 30 (1999)
- aining lead which may be ingested ead, lead paint or any other materials o naled or absorbed, except where copper alloy fittings also ed in drinking water pipework by any releva rings are specifically p
- which may be hazardous with reference to the limits set by the Health a Executive;
- calcium silica
- vermiculite unless it is established as being fibre-
- ning cadmium referred to in Statutory Instrument 'SI Controls on dance should also be made to 'HSE IDGE391 Cadmium and
- any new timber treated with pentachlorop
- non galvanise to erosion
- concrete use
- materials containing chlorofluorocarbons (CFC's):
- solvent based paints except where water base any new materials not in accordance with statutory requirements. British Standards
- Codes of Practice and good building practice current at the date of inco the relevant materials into the Works or the specifications thereof;
- (B) Updated in accordance with meeting comments 06-02-2020. Feb 2020 / SAJ A North point added. Design development Nov 2019 / SAJ  $\checkmark$  First Issue Nov 2019 / SAJ REVISION DETAILS date / by ○ Preliminary For Approval  $\bigcirc$  Tender  $\bigcirc$  Construction CLIENT Young Foundations PROJECT Oaklea Grange, Sandy Lane, Hope, Wrexham, LL12 9RP DRAWING TITLE **Residential Home** Proposed First Floor Plan SCALE drawn by date 1:100@A3 Nov 2019 SAJ DRAWING NO. revision 19-140-121 **B**

- 60mins. Fire compartmentation

SCALE BAR

- 10m 9 8
  - T: 0151 207 4371 F: 0151 207 7087
- വ Ы CLA

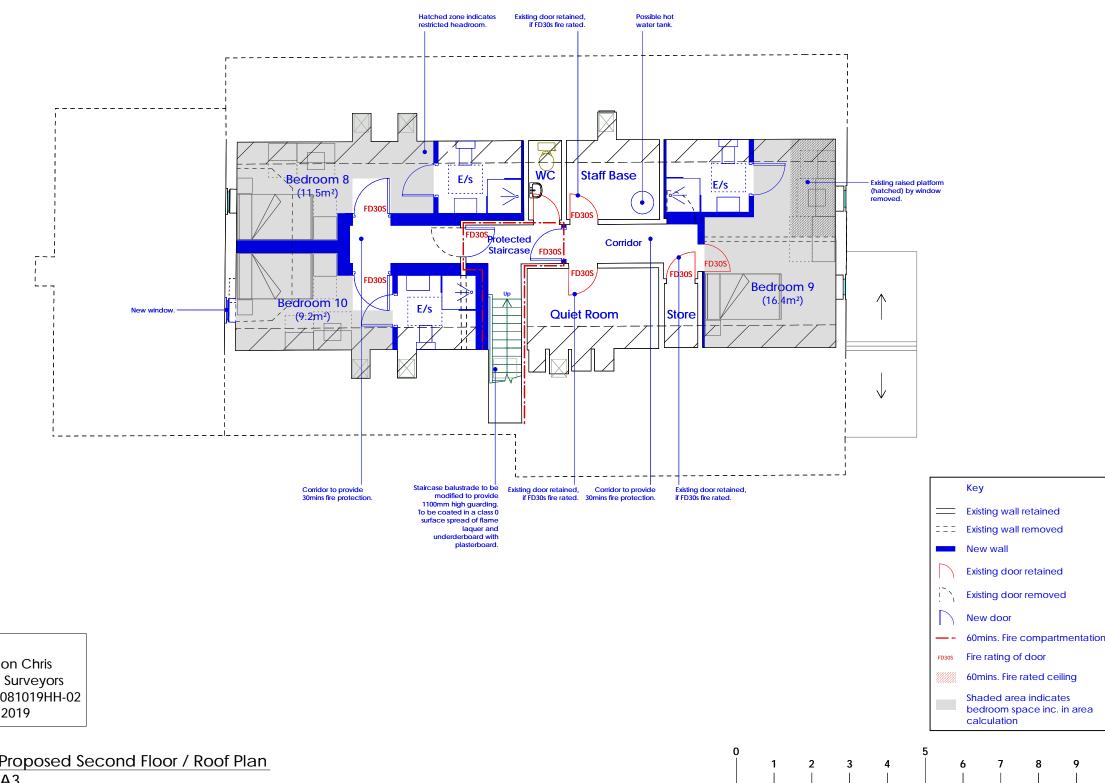

Note: Drawing based on Chris Partington Land Surveyors (CPLS) drawing 081019HH-02 dated October 2019

> Home - Proposed Second Floor / Roof Plan 1:100 @ A3



### ○ NOTES

- C This drawing is copyright of Condy and any way without their specific permission
- All dimensions are to be checked on site. Do not scale from this drawing, work to figured dimensions only. Any queries please contact the architects

### ○ MATERIALS PROHIBITED

Materials prohibited from use, except where used in accordance with 'Good Practice in of Construction Materials (March 2011)' or unless requir


- wood wool slabs in permanent formwork to concre-
- calcium chloride admixtures for use in reinforced con
- asbestos or asbestos-containing products, as defined in the 'Control of Asbestos Work Regulations, as amended 2012' or any other statutory modification or re
- any naturally occurring or man made mineral fibres (for example, rock-wool or slag col) with a thickness of 3 microns or less and a length of 200 microns or less, unless they are appropriately sealed to prevent migration of fibres
- ggregates for use in reinforced concrete which do not comply with 'BS EN 12620:2002: properties of aggregates used in concrete 'BS EN 13139:2002: Properties of aggregates used in mortar.
  - 'BS EN 13055 (Parts 1 & 2): properties of lightweight aggregate
  - nce on avoiding alkali-silica reaction and limitations on alkali co BRE Digest 330 (2004)' & 'Concrete Society Technical Report 30 (1999)'
- aining lead which may be ingeste ad, lead paint or any other materials o naled or absorbed, except where copper alloy fittings also red in drinking water pipework by any rele
- dous with reference to the limits set by the Health a Executive;
- calcium silicat
- vermiculite unless it is established as being fibre
- ining cadmium referred to in Statutory Instrumen Controls on dangerous substances and pre should also be made to 'HSE IDGE391 Cadmium and
- any new timber treated with pentachlorop
- non galvanised mild steel structural fixings for bu to erosion-
- concrete use
- materials containing chlorofluorocarbons (CFC's):
- solvent based paints except where water base any new materials not in accordance with statutory requirements. British Standards
- Codes of Practice and good building practice current at the date of inco the relevant materials into the Works or the specifications thereof;
- B Updated in accordance with meeting comments 06-02-2020. Feb 2020 / SAJ A North point added. Design development Nov 2019 / SAJ ↔ First Issue Nov 2019 / SAJ REVISION DETAILS date / bv ○ Preliminary • For Approval  $\bigcirc$  Construction CLIENT Young Foundations PROJECT Oaklea Grange, Sandy Lane, Hope, Wrexham, LL12 9RP DRAWING TITLE **Residential Home** Proposed Second Floor / Roof Plan SCALE drawn by date 1:100@A3 SAJ Nov 2019 DRAWING NO. revision 19-140-122  $(\mathbf{B})$

T: 0151 207 4371 • F: 0151 207 7087

SCALE BAR

10m 8



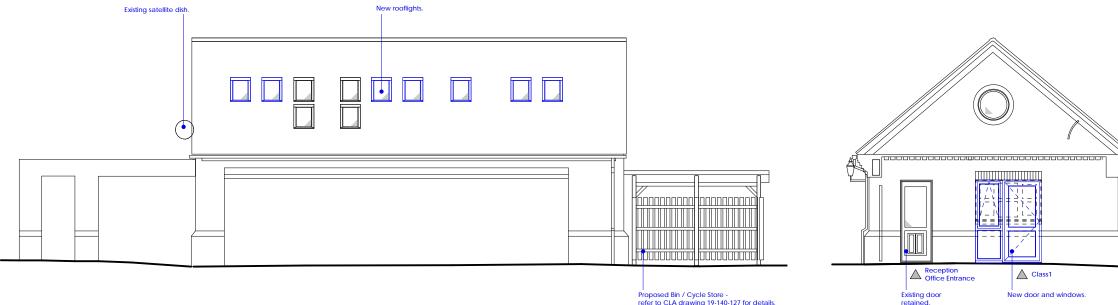

I Proposed Bin / Cycle Store -refer to CLA drawing 19-140-127 for details.

# **Elevation 3**

Note: Drawing based on Chris Partington Land Surveyors (CPLS) drawing 081019HH-02 dated October 2019

> **School - Proposed Elevations** 1:100 @ A3




Key

Existing retained

**Elevation 4** 



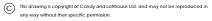

All dimensions are to be checked on site. Do not scale from this drawing, work to s only. Any que


### ○ MATERIALS PROHIBITED


aterials prohibited from use, except where used in accordance with 'Good Practice in aterials (March 2011)' or unless require


- calcium chloride admixtures for use in reinforced co
- asbestos or asbestos-containing products, as defined in the 'Control of Asbestos Work Regulations, as am nded 2012' or any other statutory n
- any naturally occurring or man made mineral fibres (for example, rock-wool or slag ool) with a thickness of 3 microns or less and a length of 200 microns or less, unless migration of fibres ney are appropriately sealed to pre
- 'BS EN 12620:2002: properties of aggregates used in concrete.
  - 'BS EN 13139:2002: Properties of aggregates used in mortar.
  - 'BS EN 13055 (Parts 1 & 2): properties of lightweight aggregates
  - Guidance on avoiding alkali-silica reaction and limitations on alkali co BRE Digest 330 (2004)' & 'Concrete Society Technical Report 30 (1999)';
- ining lead which may be ingeste ead paint or any other materia


Contract;


- urea forn which may be h ardous with reference to the limits set by the Health ar Executive;
- calcium silicate
- vermiculite unless it is established as being
- any products containing cadmium referred to in Statutory Instru Controls on dangerous substances and pre should also be made to 'HSE IDGE391 Cadmium and
- any new timber treated with pentachlorop
- non galvanised mild steel structural fixings for bui to erosion-
- concrete use
- materials containing chlorofluorocarbons (CFC's):
- solvent based paints except where water base any new materials not in accordance with statutory requirements. British Standards
- Codes of Practice and good building practice current at the date of inco the relevant materials into the Works or the specifications thereof;
- B Updated in accordance with meeting comments 06-02-2020. Feb 2020 / SAJ Nov 2019 / SAJ (A) Key plan & north point added. Design development. Nov 2019 / SAJ ★ First Issue REVISION DETAILS date / bv ○ Preliminary • For Approval  $\bigcirc$  Construction CLIENT Young Foundations PROJECT Oaklea Grange, Sandy Lane, Hope, Wrexham, LL12 9RP DRAWING TITLE School -**Proposed Elevations** drawn by date SCALE 1:100@A3 SAJ Nov 2019 DRAWING NO. revision 19-140-155  $(\mathbf{B})$ New proposed works removed T: 0151 207 4371 • F: 0151 207 7087

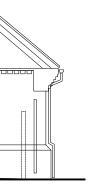

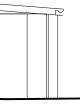

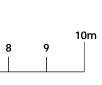


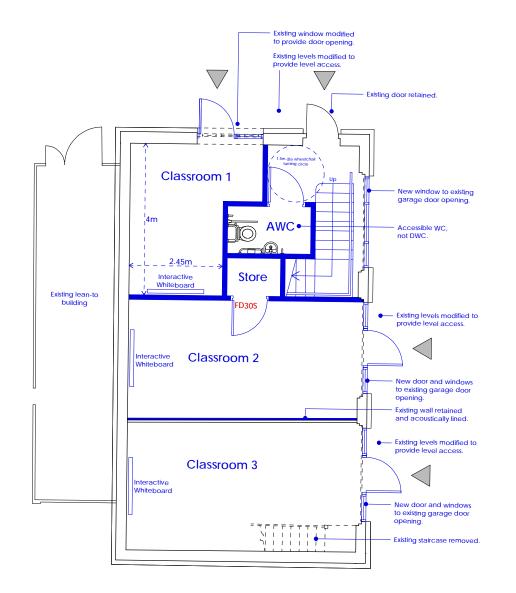

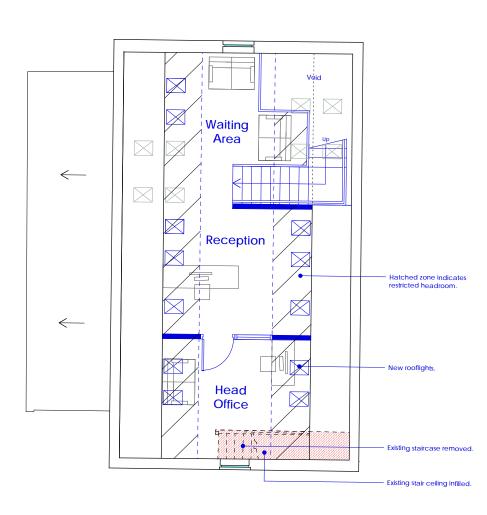

# **Ground Floor**



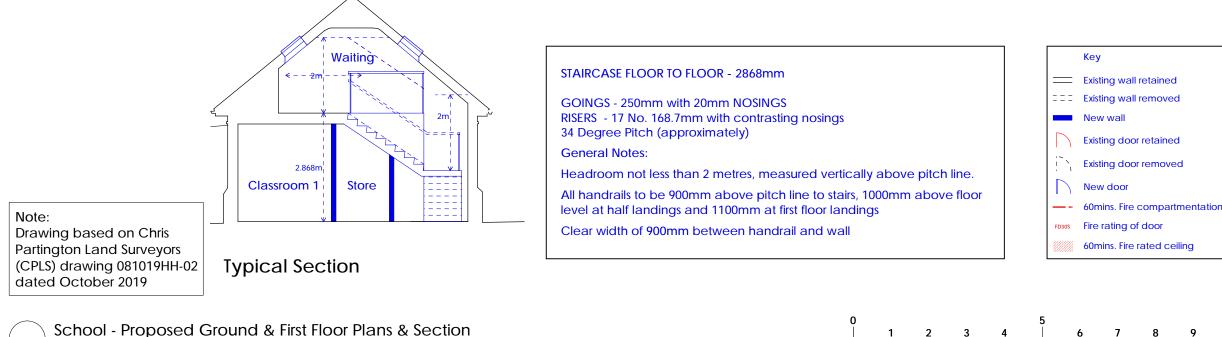

School - Proposed Ground & First Floor Plans & Section 1:100 @ A3






### $\bigcirc$ Notes


- C This drawing is copyright of Condy and Lofthouse Ltd. and may not be reproduced in any way without their specific permission.
- All dimensions are to be checked on site. Do not scale from this drawing, work to figured dimensions only. Any queries please contact the architects.

## $\bigcirc\,$ MATERIALS PROHIBITED

- a) high alumina cement in the structural elements;
- wood wooi siabs in permanent formwork to concrete;
  calcium chloride admixtures for use in reinforced concrete;
- asbestos or asbestos-containing products, as defined in the 'Control of Asbestos a Work Regulations, as amended 2012' or any other statutory modification or re-
- enactment thereof: ) any naturally occurring or man made mineral fibres (for example, rock-wool or slag wool) with a thickness of 3 microns or less and a length of 200 microns or less, unless
- they are appropriately sealed to prevent migration of fibres: f) aggregates for use in reinforced concrete which do not comply with: 'BS EN 126202002: properties of aggregates used in concrete.
  - 'BS EN 12620:2002: properties of aggregates used in concrete. 'BS EN 13139:2002: Properties of aggregates used in mortar.
  - 'BS EN 13055 (Parts 1 & 2): properties of lightweight aggregates
  - 'Guidance on avoiding alkali-silica reaction and limitations on alkali content in BRE Digest 330 (2004)' & 'Concrete Society Technical Report 30 (1999)';
- g) lead, lead paint or any other materials containing lead which may be ingested, inhaled or absorbed, except where copper alloy fittings also containing lead are specifically required in drinking water pipework by any relevant statutory requirement or where lead flashings or other lead roof coverings are specifically provided for in the Contract:
- ) urea formaldehyde foam or materials which may release formaldehyde in quantities which may be hazardous with reference to the limits set by the Health and Safety Executive;
- i) calcium silicate bricks or tiles;
- j) vermiculite unless it is established as being fibre-free; calcium silicate bricks or tile:
- any products containing cadmium referred to in Statutory Instrument SI 2006/3311 Controls on dangerous substances and preparations Regulations 2006'. Reference should also be made to 'HSE IDGE391 Cadmium and you';
- any new timber treated with pentachlorophenol;
- non galvanised mild steel structural fixings for building elements particularly susceptible to erosion;
- concrete used in circumstances where it is susceptible to alkali/silica reaction;
- materials containing chlorofluorocarbons (CFC's);
- solvent based paints except where water based paints are unsuitable for unavailable; any new materials not in accordance with statutory requirements, British Standards,
- Codes of Practice and good building practice current at the date of incorporation of the relevant materials into the Works or the specifications thereof;
- B Updated in accordance with meeting comments 06-02-2020. Feb 2020 / SAJ A North point added. Nov 2019 / SAJ Design development. (⋆) First Issue Nov 2019 / SAJ REVISION DETAILS date / bv ○ Preliminary • For Approval ○ Tender  $\bigcirc$  Construction CLIENT Young Foundations PROJECT Oaklea Grange, Sandy Lane, Hope, Wrexham, LL12 9RP DRAWING TITLE School -Proposed Floor Plans & Section drawn by date SCALE 1:100@A3 SAJ Nov 2019 DRAWING NO. revision 19-140-125 **(B**)
- 10m 8 9 | |

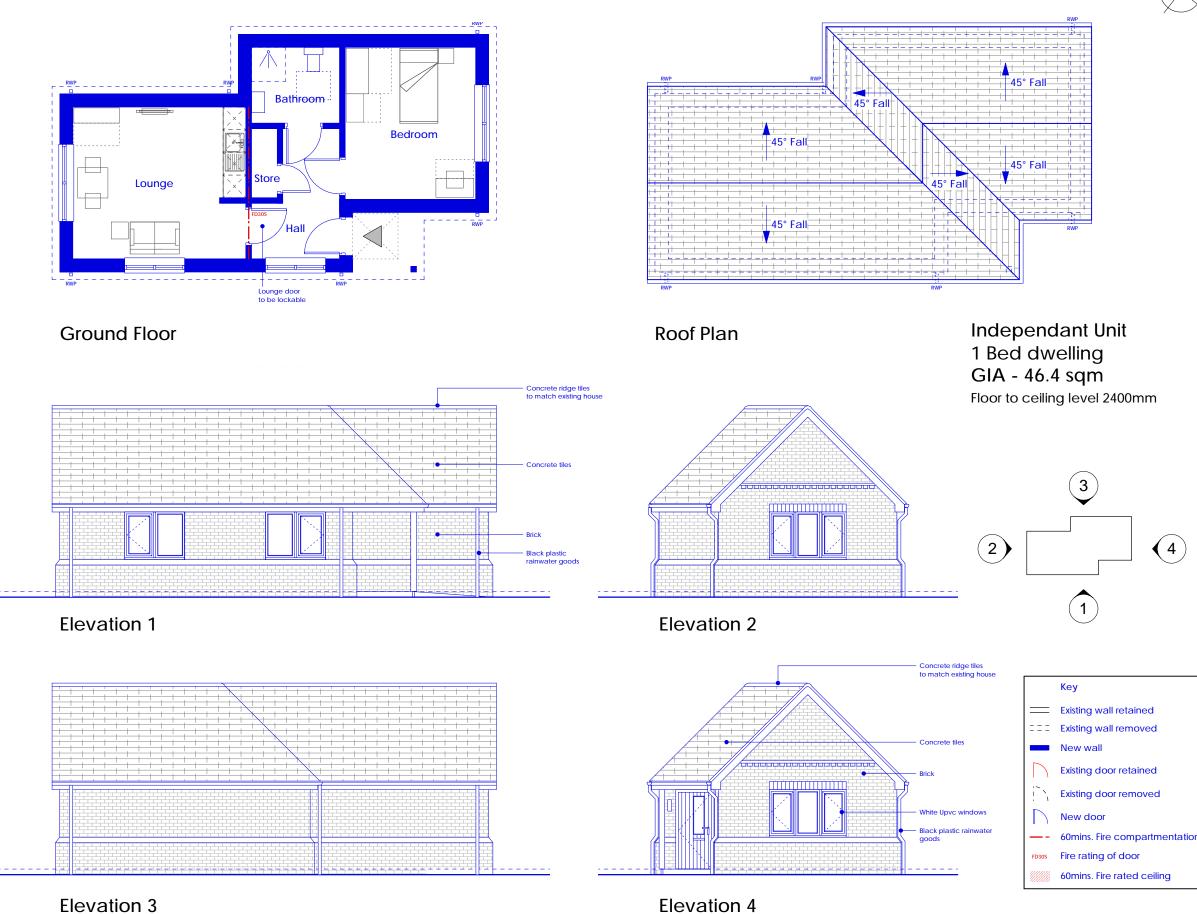



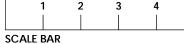



# ○ NOTES


- © This drawing is copyright of ny way without their specific perm
- sions are to be checked on site. Do  $\bigcirc$ only. Any que


## O MATERIALS PROHIBITED

als prohibited from use, except where used in accordance with 'Good Practice in

- ning products, as defined in the 'Co Work Regula ied 2012' or any othe
- ons or less and a length of 200 m
- 'BS EN 12620:2002: properties of aggregates used in cor
  - 'BS EN 13139:2002: Properties of aggregates 'BS EN 13055 (Parts 1 & 2): properties of lightweight aggrega
  - on avoiding alkali-silica reaction and limitations on alka
  - BRE Digest 330 (2004)' & 'Concrete Society Technical Report 30 (1999)
- Executive
- calcium silica
- hould also be made to 'HSE IDGE391 Cad
- to erosion
- concrete
- materials containing chlorofluorocarbons (CEC's)
- solvent based pa any new materials patie accordance with statu
- Codes of Practice and good building practice current at the date of inc the relevant materials into the Works or the specifications thereof;
- B Updated in accordance with meeting comments 06-02-2020. Feb 2020 / SAJ (A) Key plan & north point added. Design development. Nov 2019 / SAJ ↔ First Issue Nov 2019 / SAJ REVISION DETAILS date / bv • For Approval  $\bigcirc$  Construction CLIENT Young Foundations PROJECT Oaklea Grange, Sandy Lane, Hope, Wrexham, LL12 9RP DRAWING TITLE Independant Unit -Proposed Plans & Elevations drawn by date SCALE 1:100@A3 SAJ Nov 2019 DRAWING NO. revision 19-140-126 **(B)** T: 0151 207 4371 • F: 0151 207 7087

- (4)

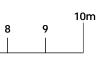

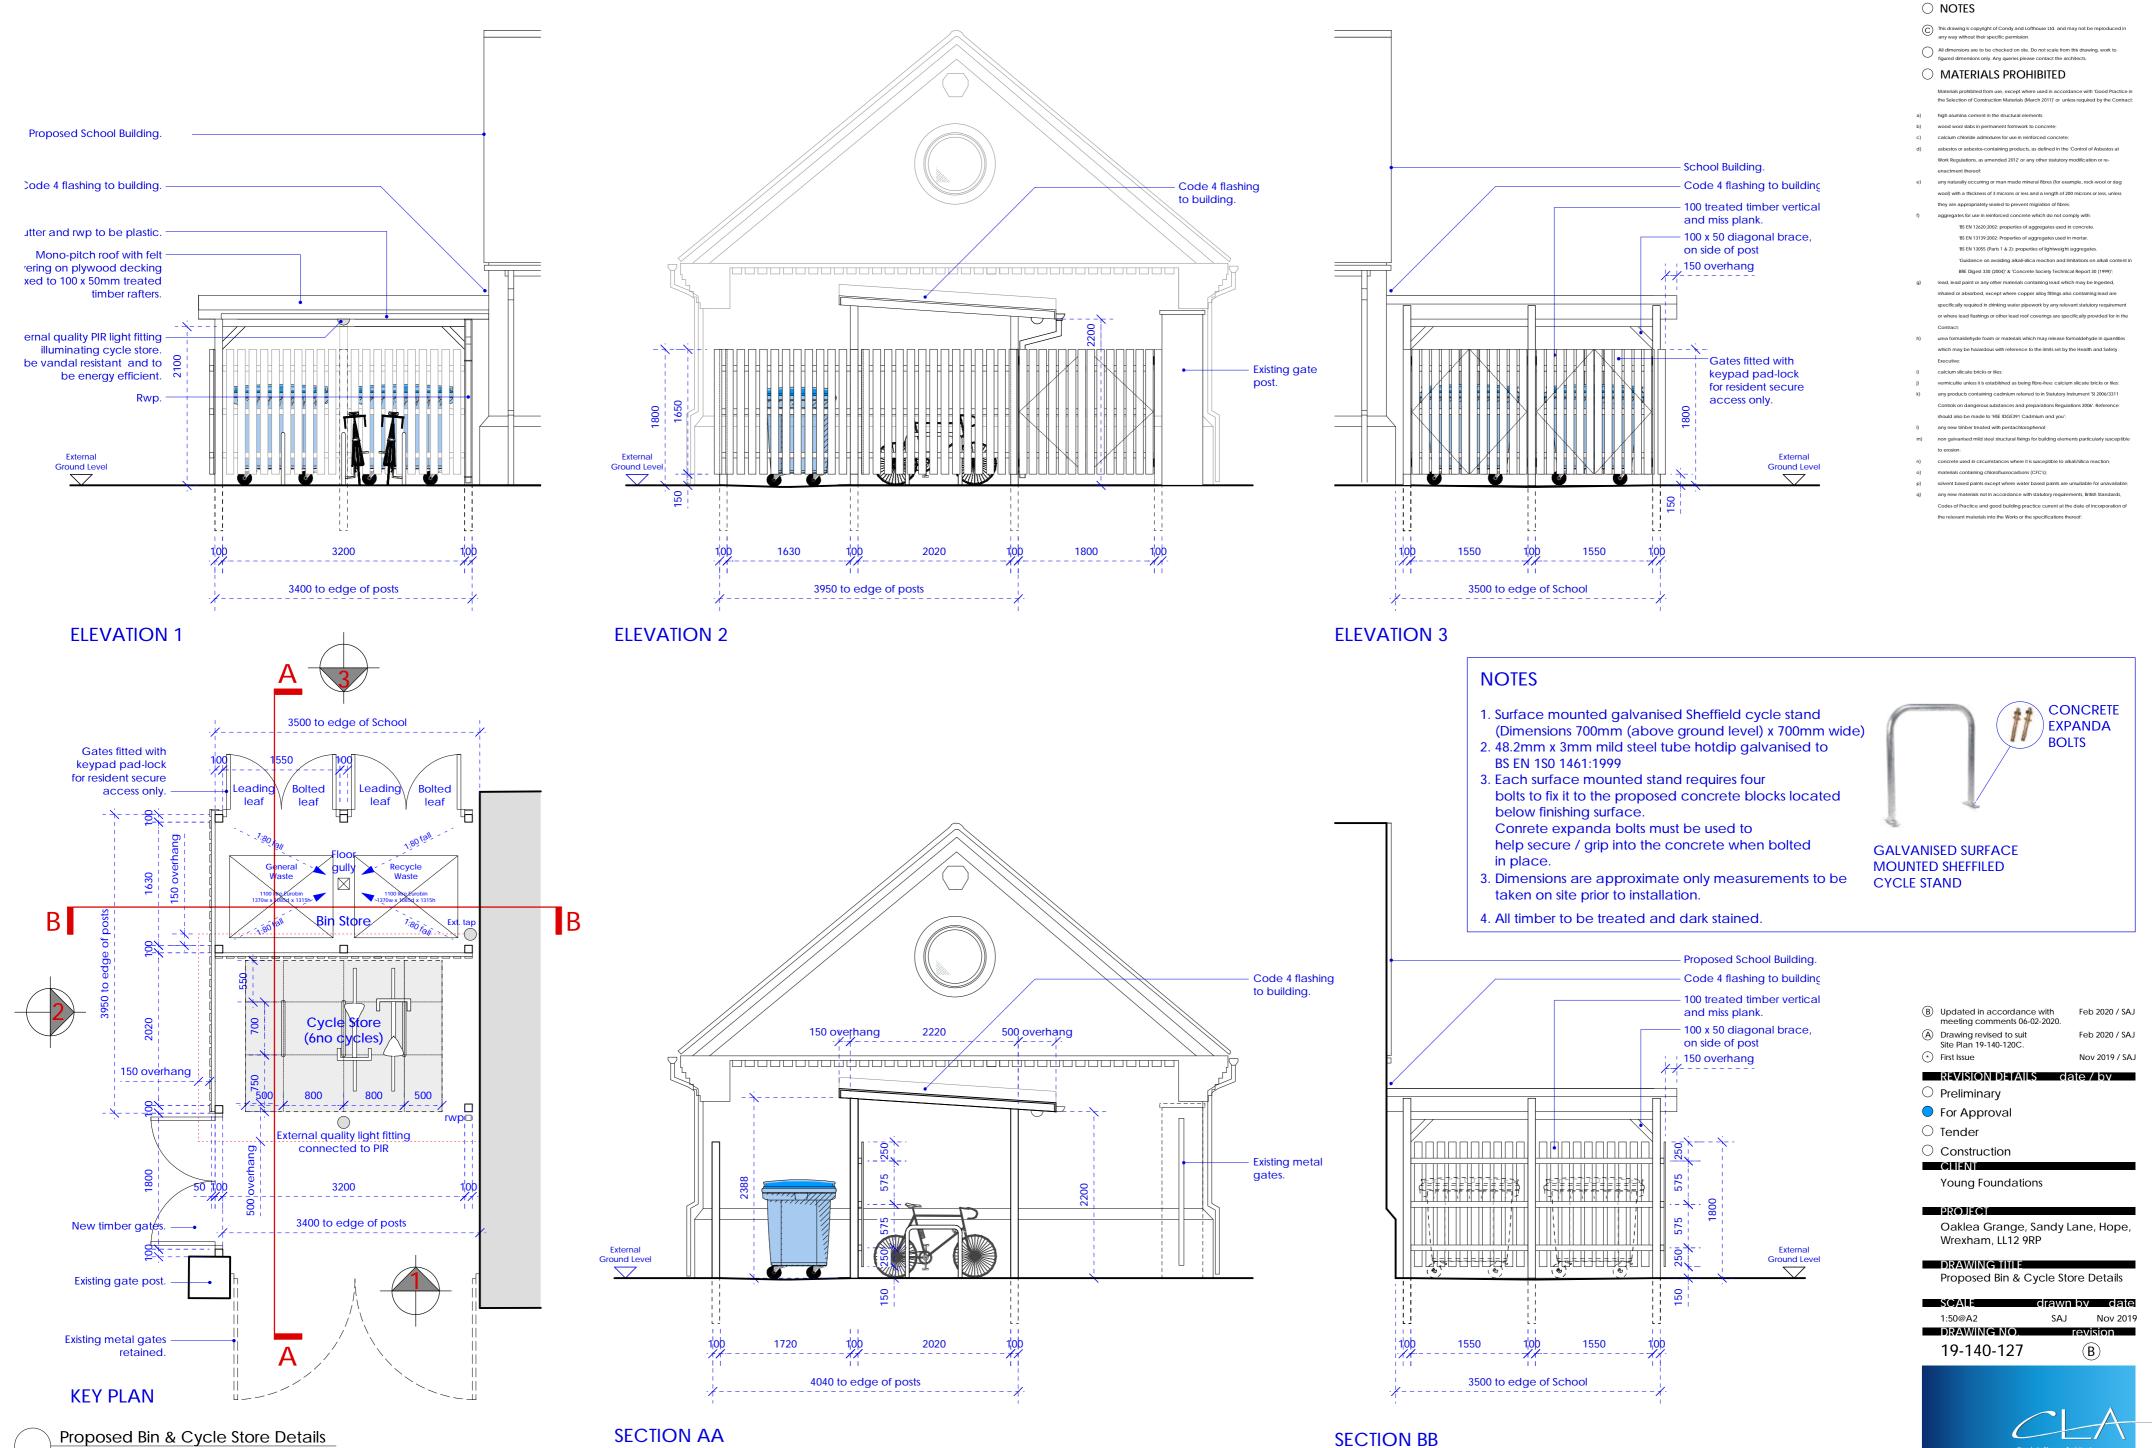

1:50 @ A2

T: 0151 207 4371 • F: 0151 207 7087